

Tel: 518.452.1290 Fax: 518.452.1335

### Town of Milton – Rowland Street Highway Facility – Cold Storage PEMB

### **Cold Storage PEMB**

### Addendum No. 1 June 12, 2023

To all holders of Contract Documents, please note the following addendum: <u>**Bid RFI's – Responses:**</u> (Item #1)

### Item #1:

1. Q: Please Verify the Insulated Metal Panel PSF. The drawings show 10, but I think the heaviest I have seen is 4.

R: 6" Insulated metal roof panel design weight shall be 4psf.

Q: Please Verify the Insulated Metal Panel PSF. The drawings show 10, but I think the heaviest I have seen is 4.
 R: Please provide 7nsf for solar allowance as system selection and extents on the roof has not yet been

R: Please provide 7psf for solar allowance as system selection and extents on the roof has not yet been determined.

3. Q: Do you want the same insulated panel under the rake and eave extensions and do they want insulated panel on the partition walls?

R: At the eave ends of the provide Metl-span low eave with metal gutter, similar to metal span detail LS1.5-R-02. At the rake ends a soffit is required but does not have the be insulated metal panel, this can be an aluminum soffit panel. Any interior partitions shown on the architectural drawings are to be cold formed metal framing and are not part of the scope of this contract.

- 4. Q: Is this bid for the supply only of this building or should the contractor include labor to erect? R: This bid is for the supply only of this building which includes PEMB structure, metal roof panels, metal wall panels, gutters, soffits and downspouts. A future bid package will be let for foundations, sitework, doors, overhead doors, and erection/installation. Date of issuance of future bid package is TBD.
- 5. Q: Is there to be a 2'-3" eave extension on both sides of the building?R: There is to be a 2'-3" eave and rake extension on both sides of the building measured from the outside face of steel. With a 3" insulated metal wall panel system specified the resulting clear extension will be 2'-0".

### **<u>Contract Documents – Drawings</u>:**

(Items #2-#5)

### <u>Item #2 – G001:</u>

Updated cover sheet indicating sheets issued in addenda.

### <u>Item #3 – A001:</u>

Updated preliminary design criteria & code requirements.

223 Main Street Goshen, New York 10924 845.615-9232 548 Broadway Monticello, New York 12701 854.791.7777 55 South Main Street Oneonta, New York 13820 607.432.8073 16 East Market Street Red Hook, NY 12571 518.452.1290

### <u>Item #4 – A101:</u>

Delete lavatory & mech/electric room.

### <u>Item #5 – A800:</u>

Delete lavatory & mech/electric room doors.

If you have any questions, or require additional information, please feel free to contact Cody Messier, PE at <u>cmessier@delawareengineering.com</u>, 518-452-1290.

Respectfully Submitted,

DELAWARE ENGINEERING, D.P.C.

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Cody Messier, P.E.

Attachments:

• Attachment #1 – Updated Architectural Drawings

# ROWLAND STREET HIGHWAY FACILITY COLD STORAGE BUILDING TOWN OF MILTON SARATOGA COUNTY, NY MAY 2023



# **COLD STORAGE BUILDING:**

Sheet Number	Sheet Name	BID PLANS -	ADDENDA #1 -
		05.26.2023	06.12.2023
G001	COVERSHEET	Х	Х
A001	CODE COMPLIANCE & LIFE SAFETY PLANS	Х	Х
A002	GENERAL ARCHITECTURAL NOTES	Х	
A101	FIRST FLOOR PLAN	Х	Х
A102	ROOF FRAMING PLAN	Х	
A200	ELEVATIONS	Х	
A300	ARCH DETAILS	Х	
A800	DOOR & WINDOW OPENING SCHEDULE & DETAILS	x	Х

TOWN BOARD MEMBERS SCOTT OSTRANDER, SUPERVISOR RYAN ISACHESEN, COUNCILMAN JOHN FROLISH, COUNCILMAN FRANK BLAISDELL, COUNCILMAN BARBRA KERR, COUNCILWOMAN

	DATE:       05.26.2023         DRAWN BY:       CAM         SCALE:       12" = 1'-0"         REVIEWED BY:       CAM         PROJECT NO:       23-2654         FILE:
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	NOT FOR CONS. BID PACKAGE SUBMISSION
	REVISIONS         NO.       DATE       DESCRIPTION         1       06/12/2023       Addenda #1         1       06/12/2023       Addenda #1
	TOWN OF MILTON - COLD STORAGE ROWLAND STREET MILTON, NY 12020
	COVERSHEET
WARNING - IT IS A VIOLATION OF NEW YORK EDUCATION LAW SECTION 7209.2, FOR ANY PERSON, UNLESS HE IS ACTING UNDER THE DIRECTION OF A LICENSED PROFESSIONAL ENGINEER OR LAND SURVEYOR, TO ALTER THIS DOCUMENT IN ANY WAY. IF ALTERED THI ALTERING PERSON SHALL COMPLY WITH THE REQUIREMENTS OF NEW YORK EDUCATION LAW, SECTION 7209.2.	SHEET: G001

# SHEET INCLUDED FOR **REFERENCE ONLY**

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HEIGHT & AREA – AI	LOWABLE			(CHAPTER 5)
AREA PER TABLE 504	.3 & 506.2			(CHAPTER 3)
OCCUPANCY	TABULAR AREA	TABUL	AR HEIGHT	
CLASSIFICATION		FEET	STORIES	INCREASE DUE TO FRONTAGE
U	8,500 SF	55 FT	2	ALLOWED, THEREFORE ALLOWABLE
				AREA INCREASED TO 14,875 SF

🗌 13 🗌 13R

28' – 3"

BUILDING AREA

11,644 SF

11,644 SF

HEIGHT IN FEET | HEIGHT IN STORIES

APPLICABLE TO THIS PROJECT. CONTRACTOR SHALL CONSTRUCT THE PROJECT IN ACCORDANCE WITH THE APPLICABLE CODES.

**APPLICABLE CODE:** 

SINGLE MIXED NON-SEPARATED COMBINATION

IF SEPARATED, FIRE RESISTANCE RATING OF FIRE BARRIER (TABLE 508.4):

AUTOMATIC SPRINKLER SYSTEM PROVIDED: 🗆 YES 🛛 NO

USES: HIGHWAY VEHICLE & MISCELLANEOUS STORAGE

CONSTRUCTION CLASSIFICATION (CHAPTER 6):

**BUILDING DATE & CODE** 

NFPA STANDARD:

BUILDING HEIGHT

FIRST

HEIGHT & AREA - ACTUAL

BUILDING AREA SUMMARY

TOTAL (NOT INCLUDING BASEMENT)

**OCCUPANCY CLASSIFICATION:** 

OCCUPANCY CLASSIFICATION(S): U

- HAT MAY APPLY.
- EVANT TO THIS PROJECT. PROJECT.

NOTE: DESIGN OCCUPANT LOAD FOR MEANS OF EGRESS SIZING.

(CHAPTERS 3 & 5)

(CHAPTER 5)

HR

REQUIRED 2.8 NA 44" MIN

**FIRE PROTECTION SYSTEMS:** 

FIRE PROTECTION SYSTEM

ALTERNATIVE AUTO FIRE EXIT

PORTABLE FIRE EXTINGUISHER

FIRE ALARM & DETECTION

SMOKE CONTROL SYSTEM

FIRE COMMAND CENTER

DESIGN OCCUPANT LOAD SUMMARY

SMOKE & HEAT VENTS

**MEANS OF EGRESS:** 

FLOOR LEVEL

FIRST

TOTAL

EMERGENCY ALARM

AUTOMATIC SPRINKLER


STANDPIPE

## 

PLUMBING FIXTURE REQUIREMENTS:					
		١	NATEF	CLOS	
		M	EN	W	
OCCUPANCY CLASSIFICATION	OCCUPANT LOAD	REQUIRED	PROVIDED	REQUIRED	
U	58	0	0	0	

ES REQUIRED? ILITIES COMPLIES? ES COMPLIES?

EQUIREMENTS?

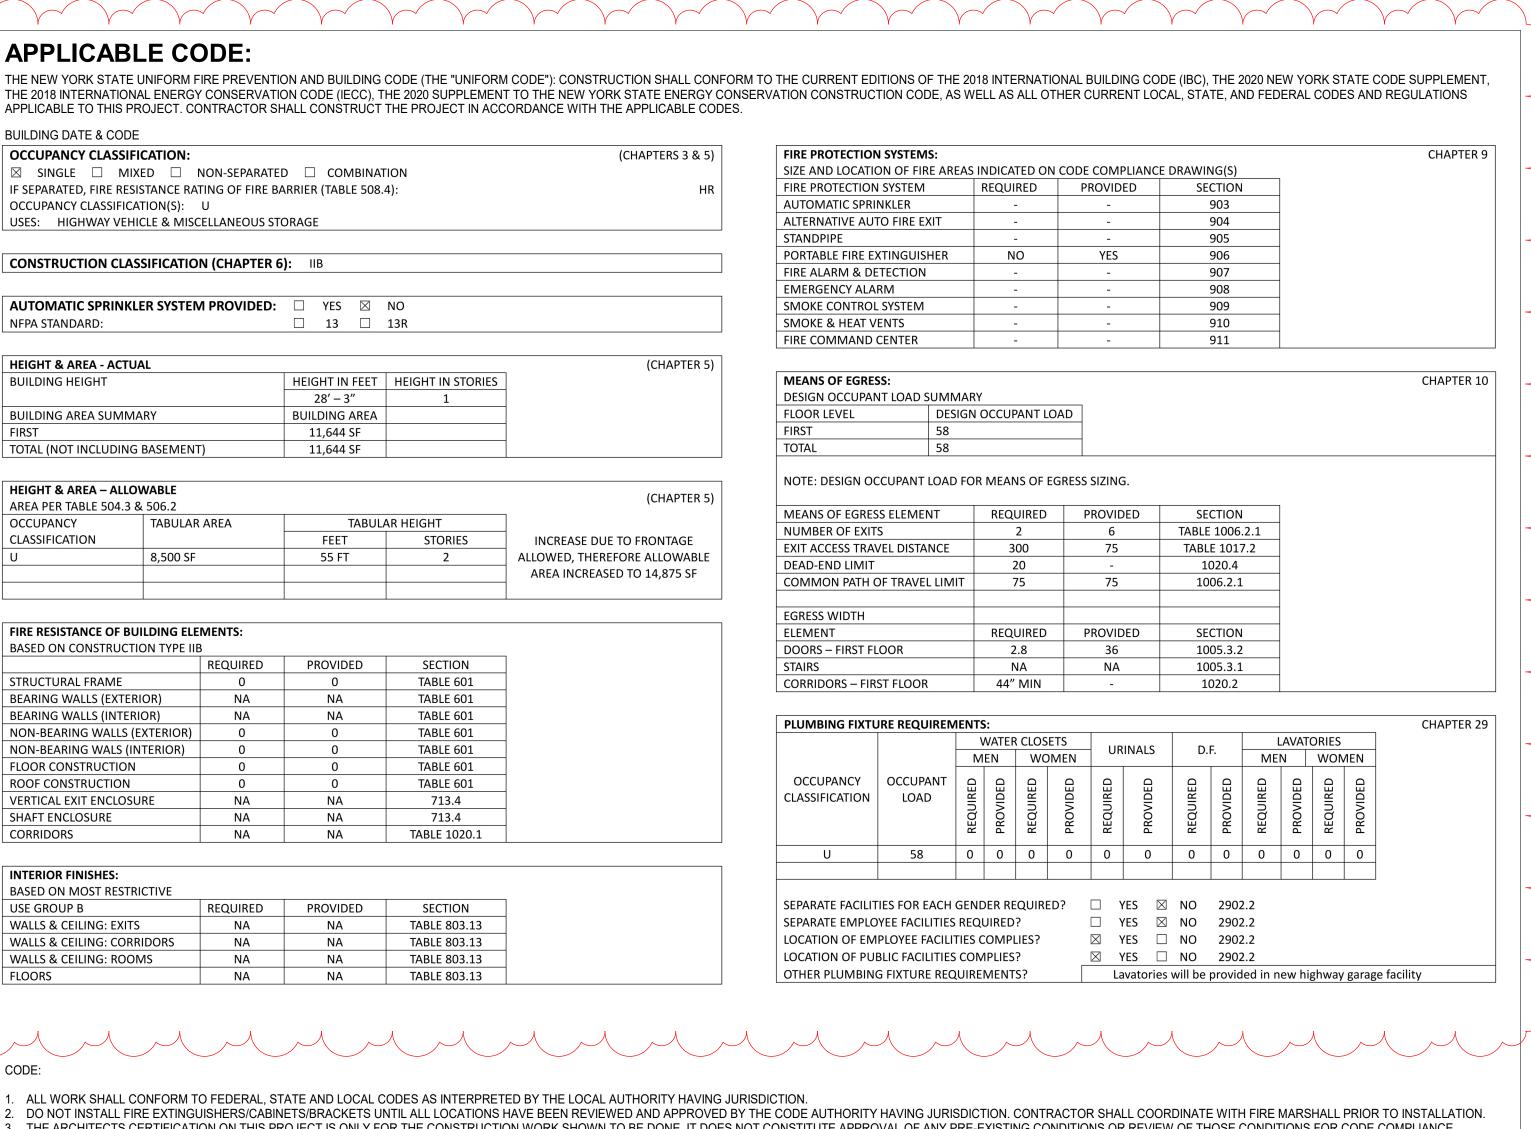

PRE-EXISTING CONDITIONS OR REVIEW OF THOSE CONDITIONS FOR CODE COMPLIANCE. ARDS, FOR PURPOSES OF OBTAINING A BUILDING PERMIT THROUGH THE AUTHORITY HAVING


E INCORPORATED INTO THE OWNER-CONTRACTOR CONTRACT BY REFERENCE. DNSTRUCTION SHALL CONFORM TO CURRENT EDITIONS OF THE 2018 INTERNATIONAL BUILDING TO THE NEW YORK STATE ENERGY CONSERVATION CONSTRUCTION CODE, 2010 AMERICANS IES (ICC/ANSI A117.1-2009), AS WELL AS WITH ALL OTHER CURRENT LOCAL, STATE AND FEDERAL

RK STATE ENERGY CONSERVATION CONSTRUCTION CODE.

IS LAW FOR ANY PERSON UNLESS HE IS ACTING UNDER THE DIRECT SUPERVISION OF A S SEAL AND NOTATION "ALTERED BY" FOLLOWED BY HIS SIGNATURE AND DATE OF SUCH

IERGY CODE REQUIR	EMENTS
E NEW STRUCTURE COMPLIES WITH THE QUIREMENTS, PRESCRIPTIVE METHOD	2020 NYS BUILDING CODE
IMATE ZONE (IECCNYS TABLE C301.1):	5A - SARATOGA COUNTY
<u>POF (IECCNYS C402.1.4):</u> REQUIRED: PROVIDED:	METAL BUILDING U ≤ 0.035 U = 0.022
NOTE: PRE-ENGINEERED BUILDING MAN PROVIDING ENERGY CODE REQUIREMEN STIPULATED IN THE CONTRACT DOCUME	NTS IN WALL AND ROOF ASSEMBLY AS
ALLS, ABOVE GRADE (IECCNYS C402.1.4): REQUIRED: PROVIDED:	METAL BUILDING U ≤ 0.052 U = 0.039
NOTE: PRE-ENGINEERED BUILDING MAN PROVIDING ENERGY CODE REQUIREMEN STIPULATED IN THE CONTRACT DOCUME	NTS IN WALL AND ROOF ASSEMBLY AS
ALLS, BELOW GRADE (IECCNYS C402.1.3): REQUIRED: PROVIDED:	CONCRETE R ≥ 7.5 Cl R = 10 Cl
OORS (IECCNYS C402.1.3): REQUIRED: PROVIDED:	UNHEATED SLAB-ON-GRADE R ≥ 10 R = 10
ORS (IECCNYS C402.1.3): REQUIRED: PROVIDED:	OPAQUE NON-SWINGING DOORS R ≥ 4.75 R = NA
<u>OORS (IECCNYS C402.1.4):</u> REQUIRED: PROVIDED:	SWINGING DOORS U ≤ 0.37 U = NA
NESTRATION REQUIREMENTS (IECCNYS	<u>C402.4):</u>
<ul> <li>FIXED</li> <li>REQUIRED:</li> <li>PROVIDED:</li> </ul>	U ≤ 0.38 U = NA
<ul> <li>B. ENTRANCE DOOR</li> <li>REQUIRED:</li> <li>PROVIDED:</li> <li>OPERABLES</li> </ul>	U ≤ 0.77 U = 0.43
REQUIRED:     PROVIDED:	U ≤ 0.45 U = NA
AXIMUM FENESTRATION ALLOWABLE (IEC	
REQUIRED: PROVIDED:	0.30 NA
REQUIRED TOTAL: PROVIDED TOTAL:	2125 SF 0 SF
INIMUM SKYLIGHT FENESTRATION (IECC) NOT APPLICABLE	NYS C402.4.2):
<u>(RITTEN STATEMENT:</u> TO THE BEST OF OUR KNOWLEDGE, BEL	

JUDGEMENT. THE DESIGN IS IN COMPLIANCE WITH THE ENERGY CODE, THIS STATEMENT IS BEING PROVIDED AS REQUIRED OF THE 2020 NYS ENERGY

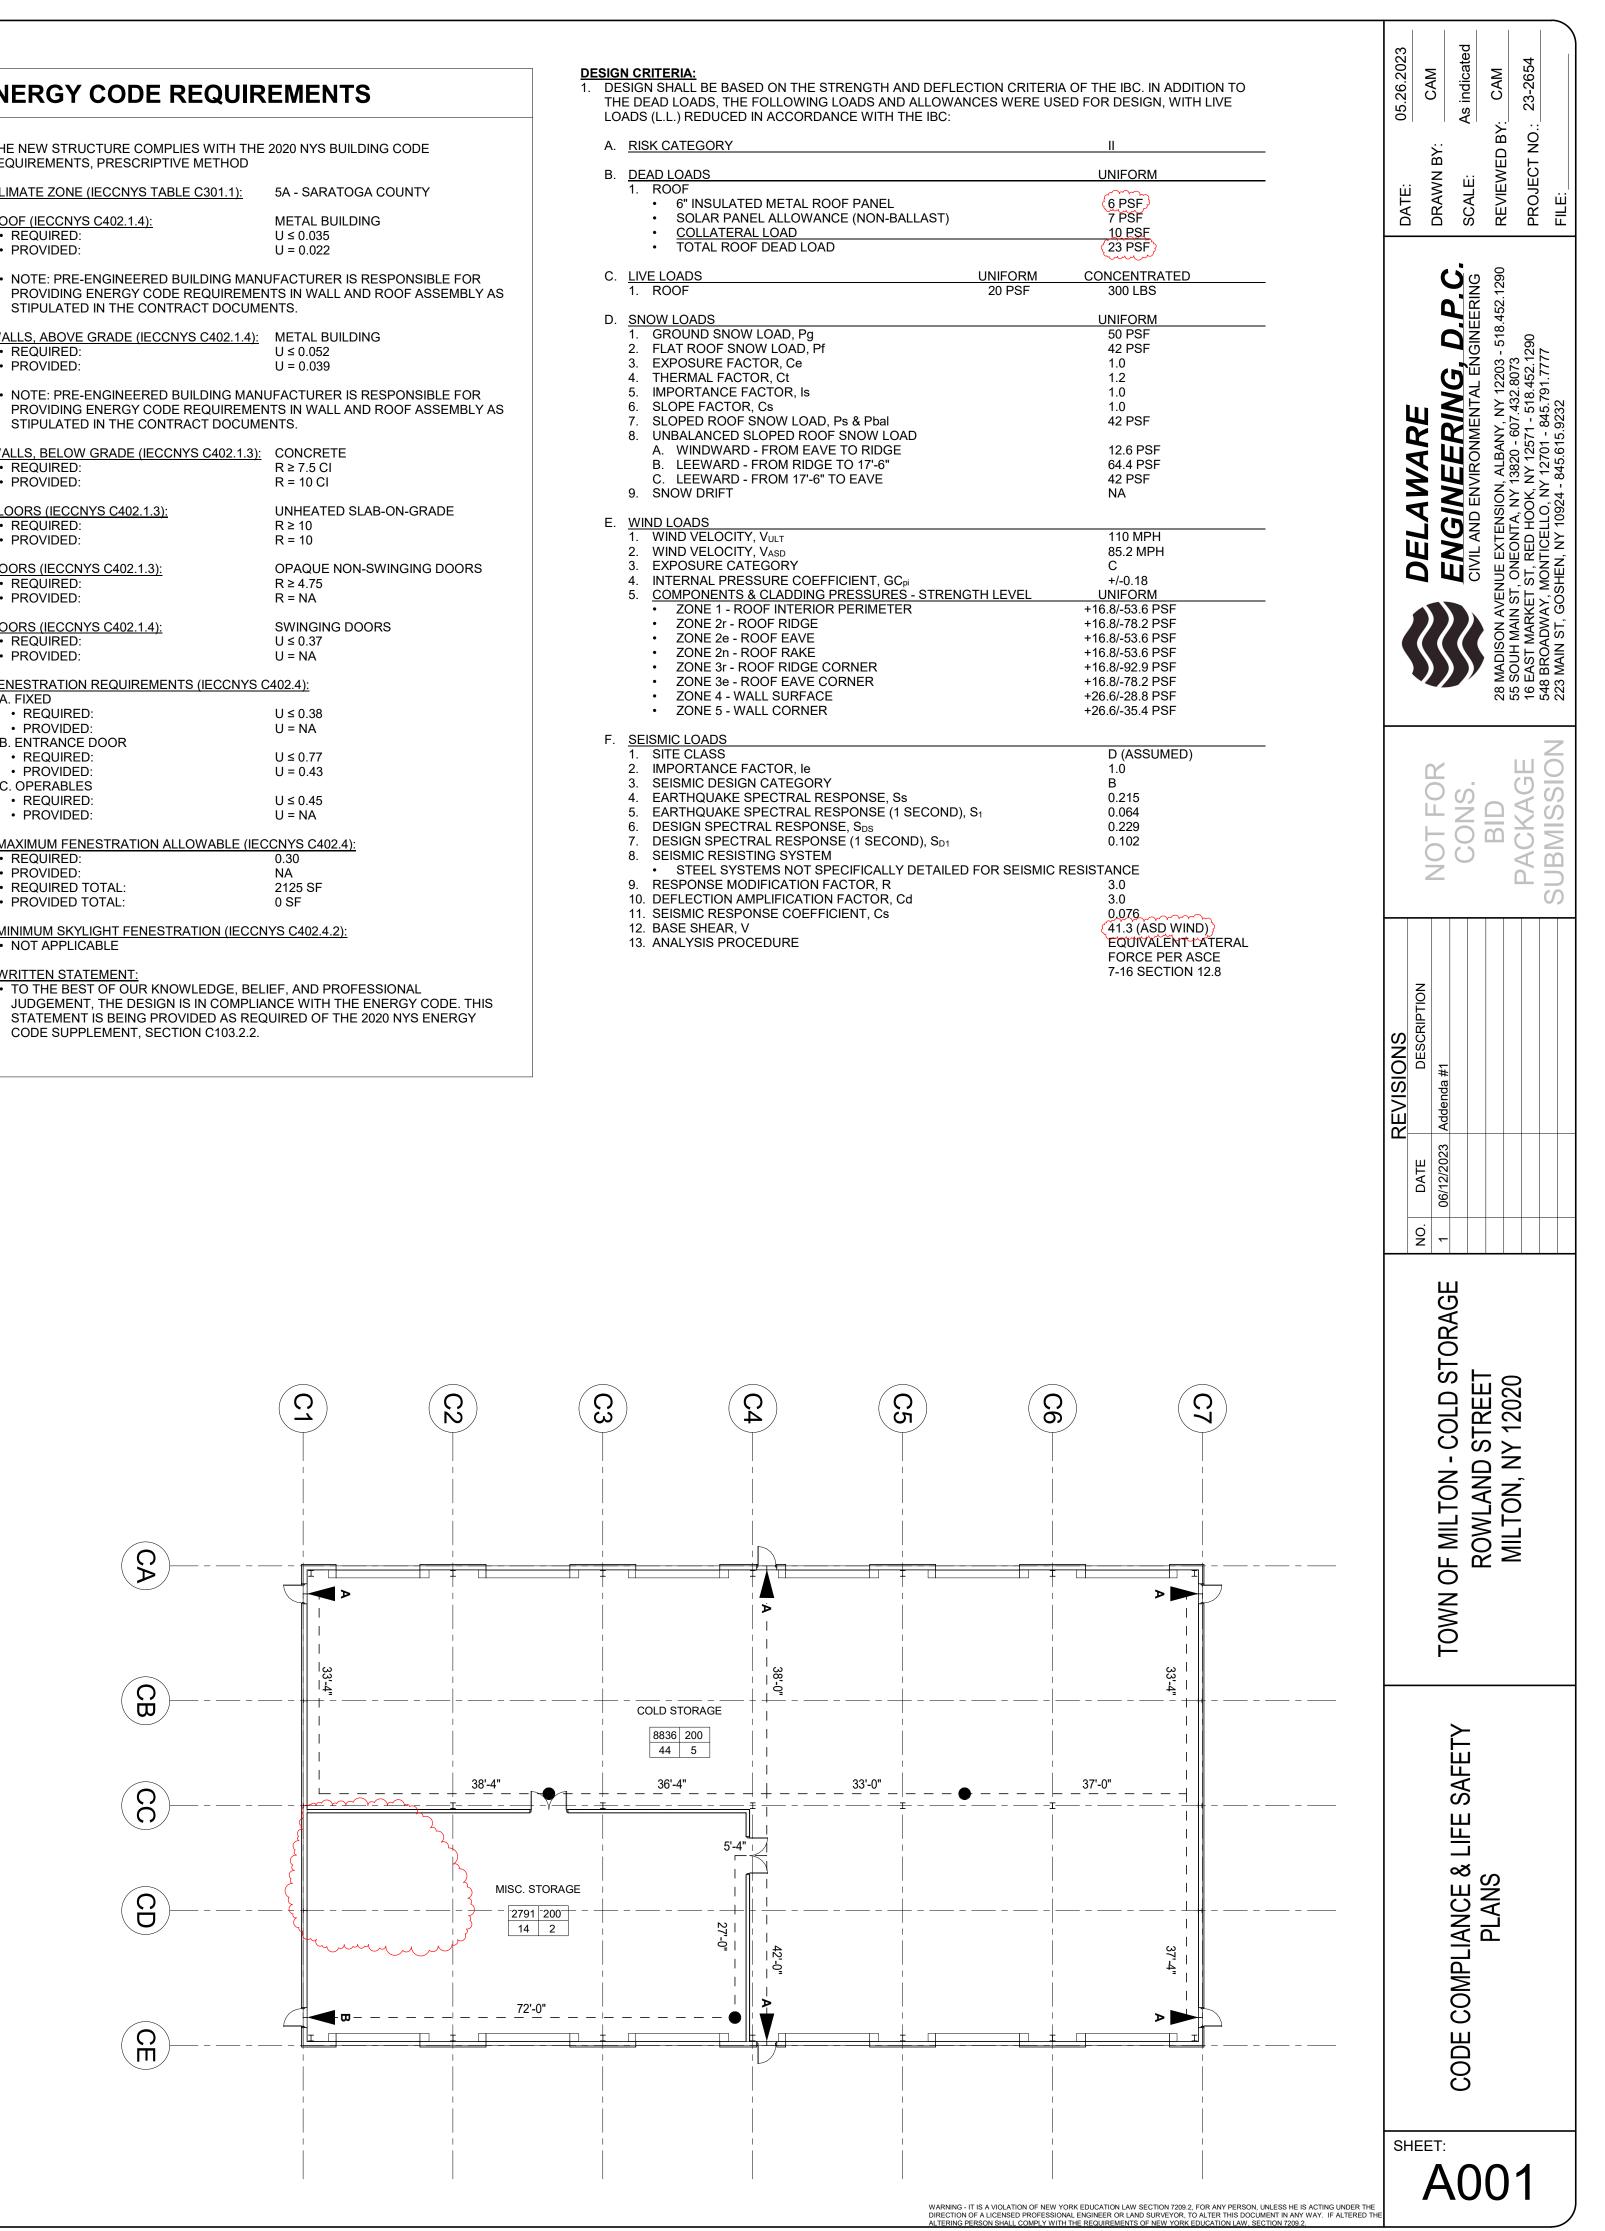

## ARCHITECTURAL LEGEND


<b>(</b> # <b>)</b>	INDICATES KEYED NOTE.	
<b>w</b> ->	<ul> <li>INDICATES NEW WALL, REF WALL SCHEDULE.</li> </ul>	-
	INDICATES NEW WINDOW, REF WINDOW SCHEDULE ON 'A' DWGS	3
	INDICATES NEW DOOR, REF DOO SCHEDULE ON 'A' DWGS	R
	INDICATES NEW GRIDLINE	


<u>PLAN NOTES</u>


- ALL ELEVATIONS ARE REFERENCED FROM 0'-0" = LEVEL 1 FINISH FLOOR.
- 2. GRIDLINES ARE LOCATED AT EXTERIOR FACE OF PEMB STEEL LINES.
- 3. DETAILS ON THESE PLANS ARE INTENDED TO DEPICT THE GENERAL CONSTRUCTION METHODS FOR THIS STRUCTURE. CONNECTIONS, DETAILS AND CONDITIONS NOT SPECIFICALLY SHOWN THAT ARE SIMILAR TO THOSE THAT ARE SPECIFIED SHALL BE ASSUMED ONE AND THE SAME. IF QUESTIONS REGARDING THE APPLICATION OF DETAILS ARE ENCOUNTERED, NOTIFY THE ARCHITECT / ENGINEER FOR CLARIFICATION IN A TIMELY MANNER PRIOR TO BID OPENING.
- DOORS & WINDOWS SHOWN FOR REFERENCE ONLY. DOORS & WINDOWS SHALL BE PROCURED UNDER SEPERATE CONTRACT.
- 5. DIMENSIONS AT DOORS ARE ROUGH OPENING OF STRUCTURAL FRAME.

Mun Manner Market

- KEYNOTES (#)
- 1 INTERIOR PARTIION WALLS & DOORS PART OF SEPERATE CONTRACT AND SHOWN FOR REFERENCE ONLY.

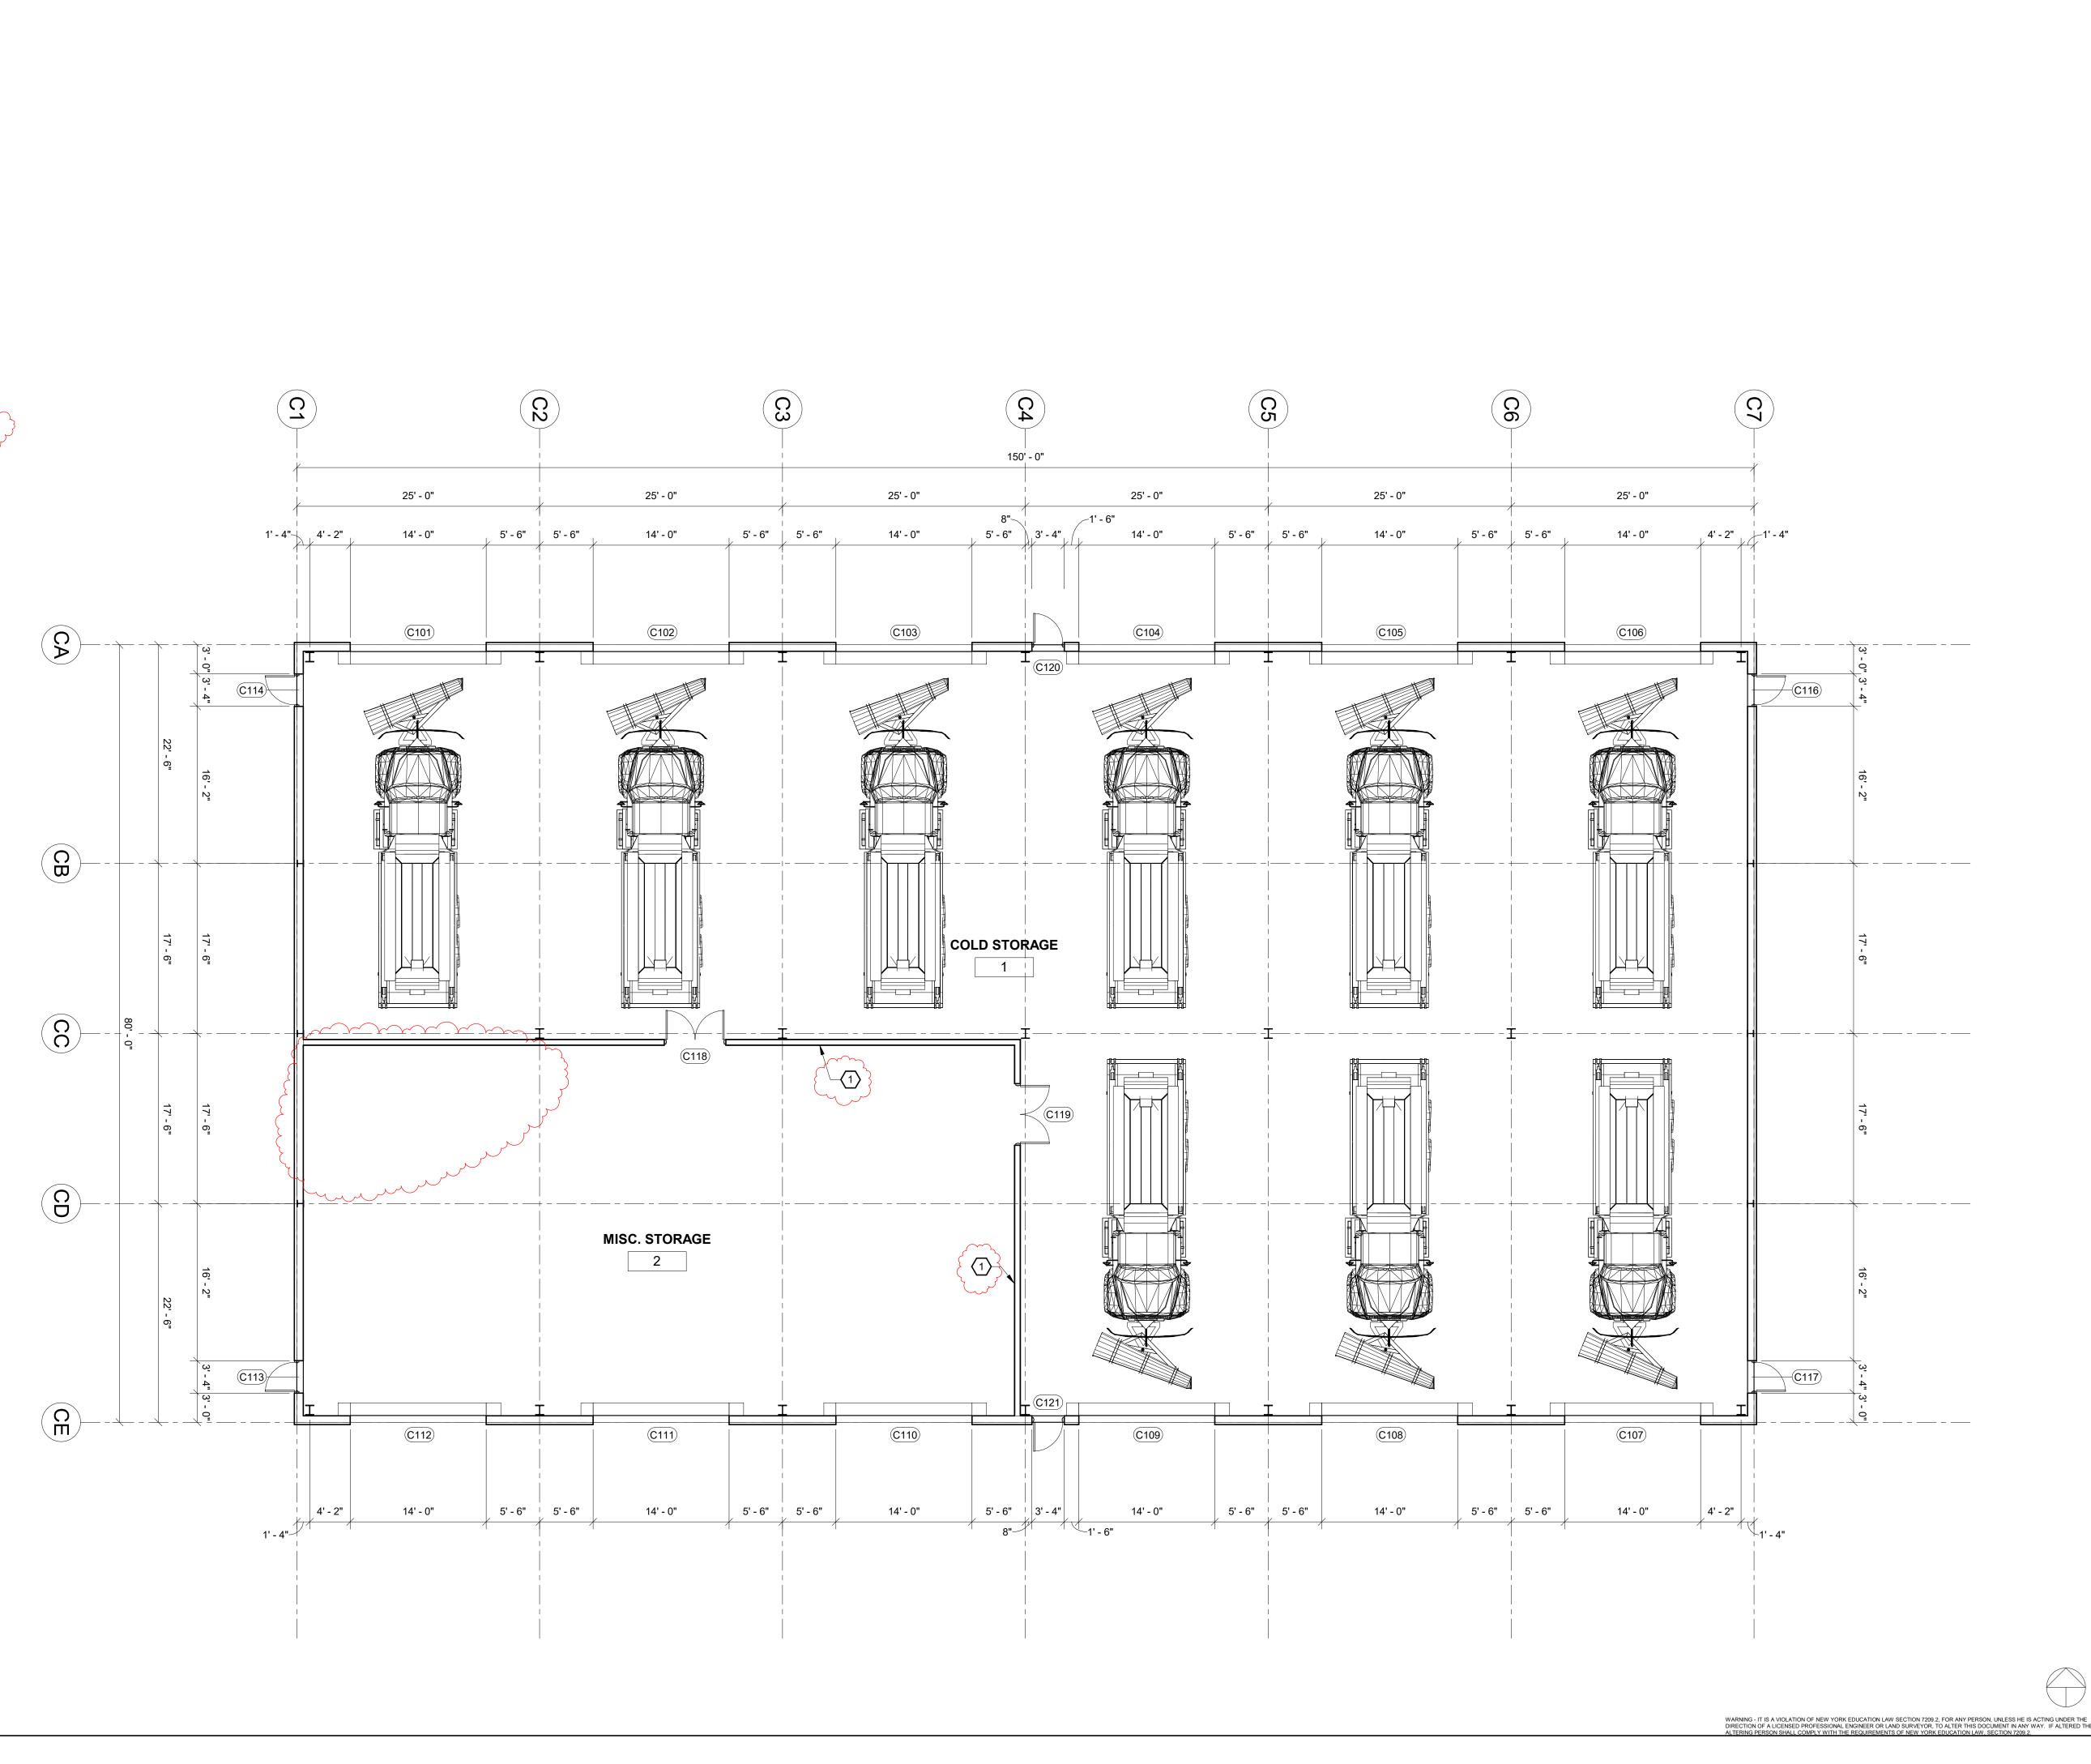

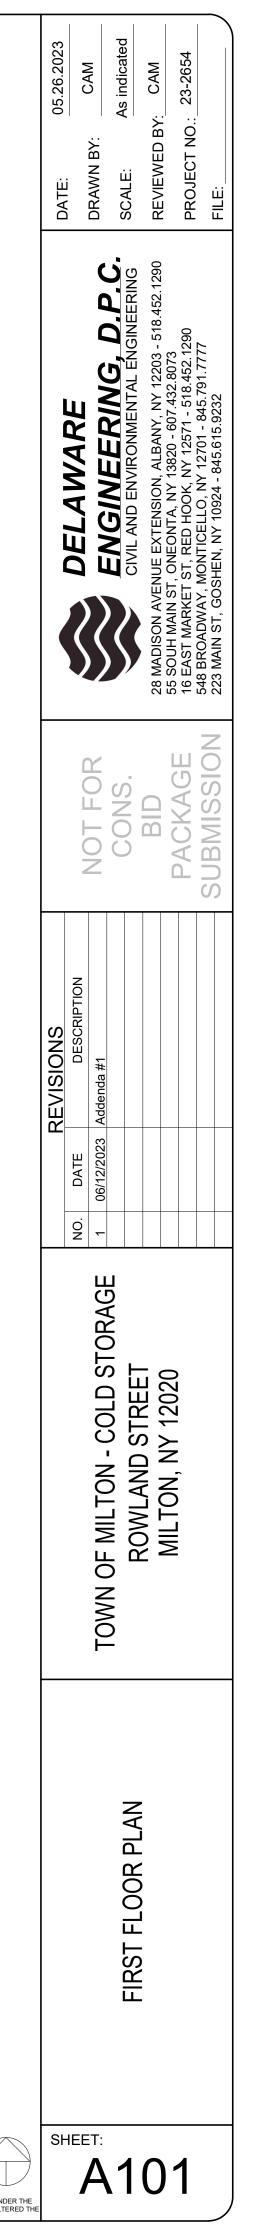

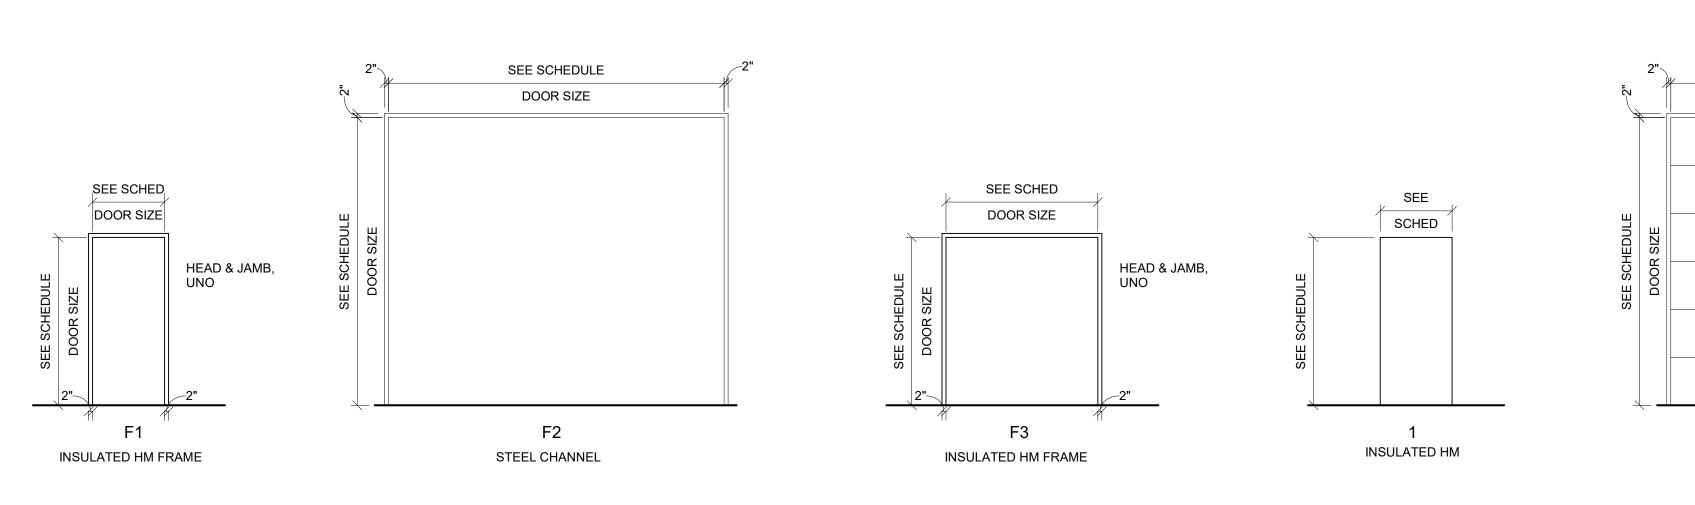

DOOR FRAME TYPES



## SHEET INCLUDED FOR REFERENCE ONLY

DOOR SCHEDULE DOOR SIZE DOOR FRAME MARK ROUGHT ROUGH HEIGHT WIDTH THICKNESS TYPE MATERIAL FINISH DEPTH MATERIAL FINISH TYPE HEIGHT WIDTH 14' - 0" C101 14' -c0" 14' - 0" 14' - 0" 1 1/2" INSULATED STEEL POWDER COAT, COLOR BY OWNER | F2 | 3" (W) x 6 1/4" (D) | STEEL MFR STD 2 1 1/2" INSULATED STEEL MFR STD C102 14' -00" 14' - 0" 14' - 0" 14' - 0" POWDER COAT, COLOR BY OWNER | F2 | 3" (W) x 6 1/4" (D) | STEEL 2 POWDER COAT, COLOR BY OWNER | F2 | 3" (W) x 6 1/4" (D) | STEEL 1 1/2" INSULATED STEEL MFR STD C103 14' -c0" 14' - 0" 14' - 0" 14' - 0" - 2 C104 14' -c0" POWDER COAT, COLOR BY OWNER | F2 | 3" (W) x 6 1/4" (D) | STEEL 14' - 0" 14' - 0" 14' - 0" 1 1/2" INSULATED STEEL MFR STD - 2 C105 14' -c0" 14' - 0" 14' - 0" 14' - 0" 1 1/2" INSULATED STEEL POWDER COAT, COLOR BY OWNER | F2 | 3" (W) x 6 1/4" (D) | STEEL MFR STD 2 C106 14' -c0" 14' - 0" 14' - 0" 14' - 0" 1 1/2" INSULATED STEEL POWDER COAT, COLOR BY OWNER | F2 | 3" (W) x 6 1/4" (D) | STEEL MFR STD 2 C107 14' -C0" 14' - 0" 14' - 0" 14' - 0" 1 1/2" INSULATED STEEL POWDER COAT, COLOR BY OWNER | F2 | 3" (W) x 6 1/4" (D) | STEEL MFR STD 2 MFR STD C108 14' -C0" 14' - 0" 14' - 0" 14' - 0" 1 1/2" INSULATED STEEL POWDER COAT, COLOR BY OWNER | F2 | 3" (W) x 6 1/4" (D) | STEEL 2 INSULATED STEEL MFR STD C109 14' -:0" 14' - 0" 14' - 0" 14' - 0" 1 1/2" POWDER COAT, COLOR BY OWNER | F2 | 3" (W) x 6 1/4" (D) STEEL 2 C110 14' -:0" 14' - 0" INSULATED STEEL MFR STD 14' - 0" 14' - 0" 1 1/2" POWDER COAT, COLOR BY OWNER | F2 | 3" (W) x 6 1/4" (D) STEEL C111 14' -c0" MFR STD 14' - 0" 14' - 0" 14' - 0" 1 1/2" INSULATED STEEL POWDER COAT, COLOR BY OWNER | F2 | 3" (W) x 6 1/4" (D) STEEL C112 14' -ር0" 14' - 0" MFR STD 14' - 0" 14' - 0" 1 1/2" INSULATED STEEL POWDER COAT, COLOR BY OWNER | F2 | 3" (W) x 6 1/4" (D) | STEEL PAINT, COLOR HOLLOW C113 7' - 2" 7' - 0" 3' - 0" 1 3/4" INSULATED HOLLOW METAL PAINT, COLOR BY OWNER F1 2" (W) x 5 3/4" (D) 3' - 4" METAL BY OWNER HOLLOW PAINT, COLOR C114 7' - 2" 1 3/4" PAINT, COLOR BY OWNER F1 2" (W) x 5 3/4" (D) 3' - 4" 7' - 0" 3' - 0" INSULATED HOLLOW METAL METAL BY OWNER HOLLOW PAINT, COLOR C116 7' - 2" 3' - 4" 7' - 0" 3' - 0" 1 3/4" INSULATED HOLLOW METAL PAINT, COLOR BY OWNER F1 2" (W) x 5 3/4" (D) METAL BY OWNER HOLLOW PAINT, COLOR C117 7' - 2" 1 3/4" PAINT, COLOR BY OWNER F1 2" (W) x 5 3/4" (D) 3' - 4" 7' - 0" 3' - 0" INSULATED HOLLOW METAL METAL BY OWNER HOLLOW PAINT, COLOR C118 7' - 2" 1 3/4" PAINT, COLOR BY OWNER F3 2" (W) x 5 3/4" (D) 7' - 0" 6' - 0" INSULATED HOLLOW METAL 6' - 4" METAL BY OWNER HOLLOW PAINT, COLOR C119 7' - 2" 6' - 4" 7' - 0" 6' - 0" 1 3/4" INSULATED HOLLOW METAL PAINT, COLOR BY OWNER F3 2" (W) x 5 3/4" (D) METAL BY OWNER HOLLOW PAINT, COLOR C120 7' - 2" 3' - 4" 7' - 0" 3' - 0" 1 3/4" INSULATED HOLLOW METAL PAINT, COLOR BY OWNER F2 2" (W) x 5 3/4" (D) 2 METAL BY OWNER HOLLOW PAINT, COLOR C121 7' - 2" 3' - 4" 7' - 0" 3' - 0" 1 3/4" 2 INSULATED HOLLOW METAL PAINT, COLOR BY OWNER F2 2" (W) x 5 3/4" (D) METAL BY OWNER

### ABBREVIATIONS:

## HM HOLLOW METAL

PF PREFINISHED PT SEMI-GLOSS PAINT STLSTEEL

D1: 1. (3) 4-1/2"x 4-1/2" HINGES

2. (1) STORAGE LOCKSET 3. (1) CLOSER

HARDWARE SCHEDULE:

- 5. (1) SWEEP 6. (1) THRESHOLD
- 4. WEATHERSTRIPPING

D2:

1. WEATHERSTRIPPING

- D3: 1. (6) 4-1/2"x 4-1/2" HINGES

2. (1) STORAGE LOCKSET 3. (2) CLOSER 4. (2) SWEEP

D4:

1. (3) 4-1/2"x 4-1/2" HINGES 2. (1) PRIVACY LOCKSET

1. (3) 4-1/2"x 4-1/2" HINGES

D5:

- 2. (1) STORAGE LOCKSET 3. (1) CLOSER
- 3. (1) CLOSER 4. (1) SWEEP 5. (1) WALL STOP
- - 4. (1) SWEEP

				DATE: 05.26.2023 DRAWN BY: CAM SCALE: As indicated REVIEWED BY: CAM PROJECT NO.: 23-2654 FILE:
SEE SCHE DOOR S	¥			Control <td< th=""></td<>
		SEE SCHED		NOT FOR CONS. BID PACKAGE SUBMISSION
2 Steel DOOF	<u>R TYPES</u>	U 3 INSULATED H	IM	REVISIONS       NO.     DATE     DESCRIPTION       1     06/12/2023     Addenda #1
DOOR FIRE RATING	MANUFACTURER	REMARKS	HARDWARE GROUP	STORAGE
N/A	OVERHEAD DOOR CORPORATION	ROLLING OVERHEAD DOOR - MODEL 627	D2	OR/
N/A	OVERHEAD DOOR CORPORATION	ROLLING OVERHEAD DOOR - MODEL 627	D2	
N/A	OVERHEAD DOOR CORPORATION	ROLLING OVERHEAD DOOR - MODEL 627	D2	COLD S STREET Y 12020
N/A	OVERHEAD DOOR CORPORATION OVERHEAD DOOR	ROLLING OVERHEAD DOOR - MODEL 627	D2	
N/A	CORPORATION OVERHEAD DOOR	ROLLING OVERHEAD DOOR - MODEL 627	D2	- ON - AND N, N
N/A	CORPORATION OVERHEAD DOOR	ROLLING OVERHEAD DOOR - MODEL 627	D2	OF MILTON ROWLANE MILTON,
N/A	CORPORATION OVERHEAD DOOR	ROLLING OVERHEAD DOOR - MODEL 627	D2	F MILT Rowl, MILTC
N/A N/A	CORPORATION OVERHEAD DOOR	ROLLING OVERHEAD DOOR - MODEL 627 ROLLING OVERHEAD DOOR - MODEL 627	D2 D2	
N/A	CORPORATION OVERHEAD DOOR	ROLLING OVERHEAD DOOR - MODEL 627	D2	TOWN
N/A	CORPORATION OVERHEAD DOOR	ROLLING OVERHEAD DOOR - MODEL 627	D2	LC
N/A	CORPORATION OVERHEAD DOOR	ROLLING OVERHEAD DOOR - MODEL 627	D2	
N/A	CORPORATION CECO ASSA-ABLOY	LEGION FLUSH	D1	Ш
N/A	CECO ASSA-ABLOY	LEGION FLUSH	D1	EDUL
N/A	CECO ASSA-ABLOY	LEGION FLUSH	D1	
N/A	CECO ASSA-ABLOY	LEGION FLUSH	D1	sc
N/A	CECO ASSA-ABLOY	LEGION FLUSH	D3	U S
N/A	CECO ASSA-ABLOY	LEGION FLUSH	D3	
N/A	CECO ASSA-ABLOY	LEGION FLUSH	D1	ETA
N/A	CECO ASSA-ABLOY	LEGION FLUSH	D1	& WINDOW OPENING SCH & DETAILS
				& WIN

SHEET: A800

WARNING - IT IS A VIOLATION OF NEW YORK EDUCATION LAW SECTION 7209.2, FOR ANY PERSON, UNLESS HE IS ACTING UNDER THE DIRECTION OF A LICENSED PROFESSIONAL ENGINEER OR LAND SURVEYOR, TO ALTER THIS DOCUMENT IN ANY WAY. IF ALTERED THE ALTERING PERSON SHALL COMPLY WITH THE REQUIREMENTS OF NEW YORK EDUCATION LAW, SECTION 7209.2.

DOOR